



JEFFERSON COUNTY DRAINAGE DISTRICT NO. 6
Karen K. Johnson, MBA, CTCD/CTCM: Chief Business Officer

6550 Walden Rd., Beaumont, Texas 77707 Phone: 409-842-1818 Fax: 409-842-2729

IFB Number: IFB 25-029/SC
IFB Title: Howell/Sue Project Materials
IFB Original Due Date: 2:00 PM, January 8, 2026
Addendum No.: 01
Issued (Date): January 5, 2026

To BIDDER: This Addendum is an integral part of the IFB package under consideration by you as a Bidder in connection with the subject matter herein identified. Jefferson County Drainage District No. 6 deems all sealed b i d s to have been proffered in recognition and consideration of the entire IFB package – **including all addenda**. For purposes of clarification, **receipt of this present Addendum by a Bidder should be evidenced by returning it (signed) as part of the Bidder's sealed bid**. If the Bid has already been received by the Jefferson County Drainage District No. 6 Purchasing Department, Bidder should return this addendum in a separate sealed envelope, clearly marked with the IFB Name, IFB Number, and Opening Date and Time, as stated above.

Reasons for issuance of Addendum No. 01: **Clarification.**

*Questions are indicated in red, and answers are indicated in green below.

- 1. Are there any drawings for these? Or plans showing how they are going? Yes, they are attached to this addendum.**
 - The "5" in item 2 and the "6" in item 3 represent the "Y" value that is called out in the TxDOT detail on pages 2 and 3 of the attached PDF. They have a standard width as shown in the detail. As for the depth of the manholes and curb inlets, that information is shown for each box/inlet on the plan and profile sheet on page 1. Page 4 is the standard TxDOT detail for manholes. Page 5 is the manhole lid detail.**


Acknowledgment of Addenda (if any):


Addendum 1 _____ Date Received _____

Addendum 2 _____ Date Received _____


Addendum 3 _____ Date Received _____

Bidder Shall Return Completed Form with Offer.

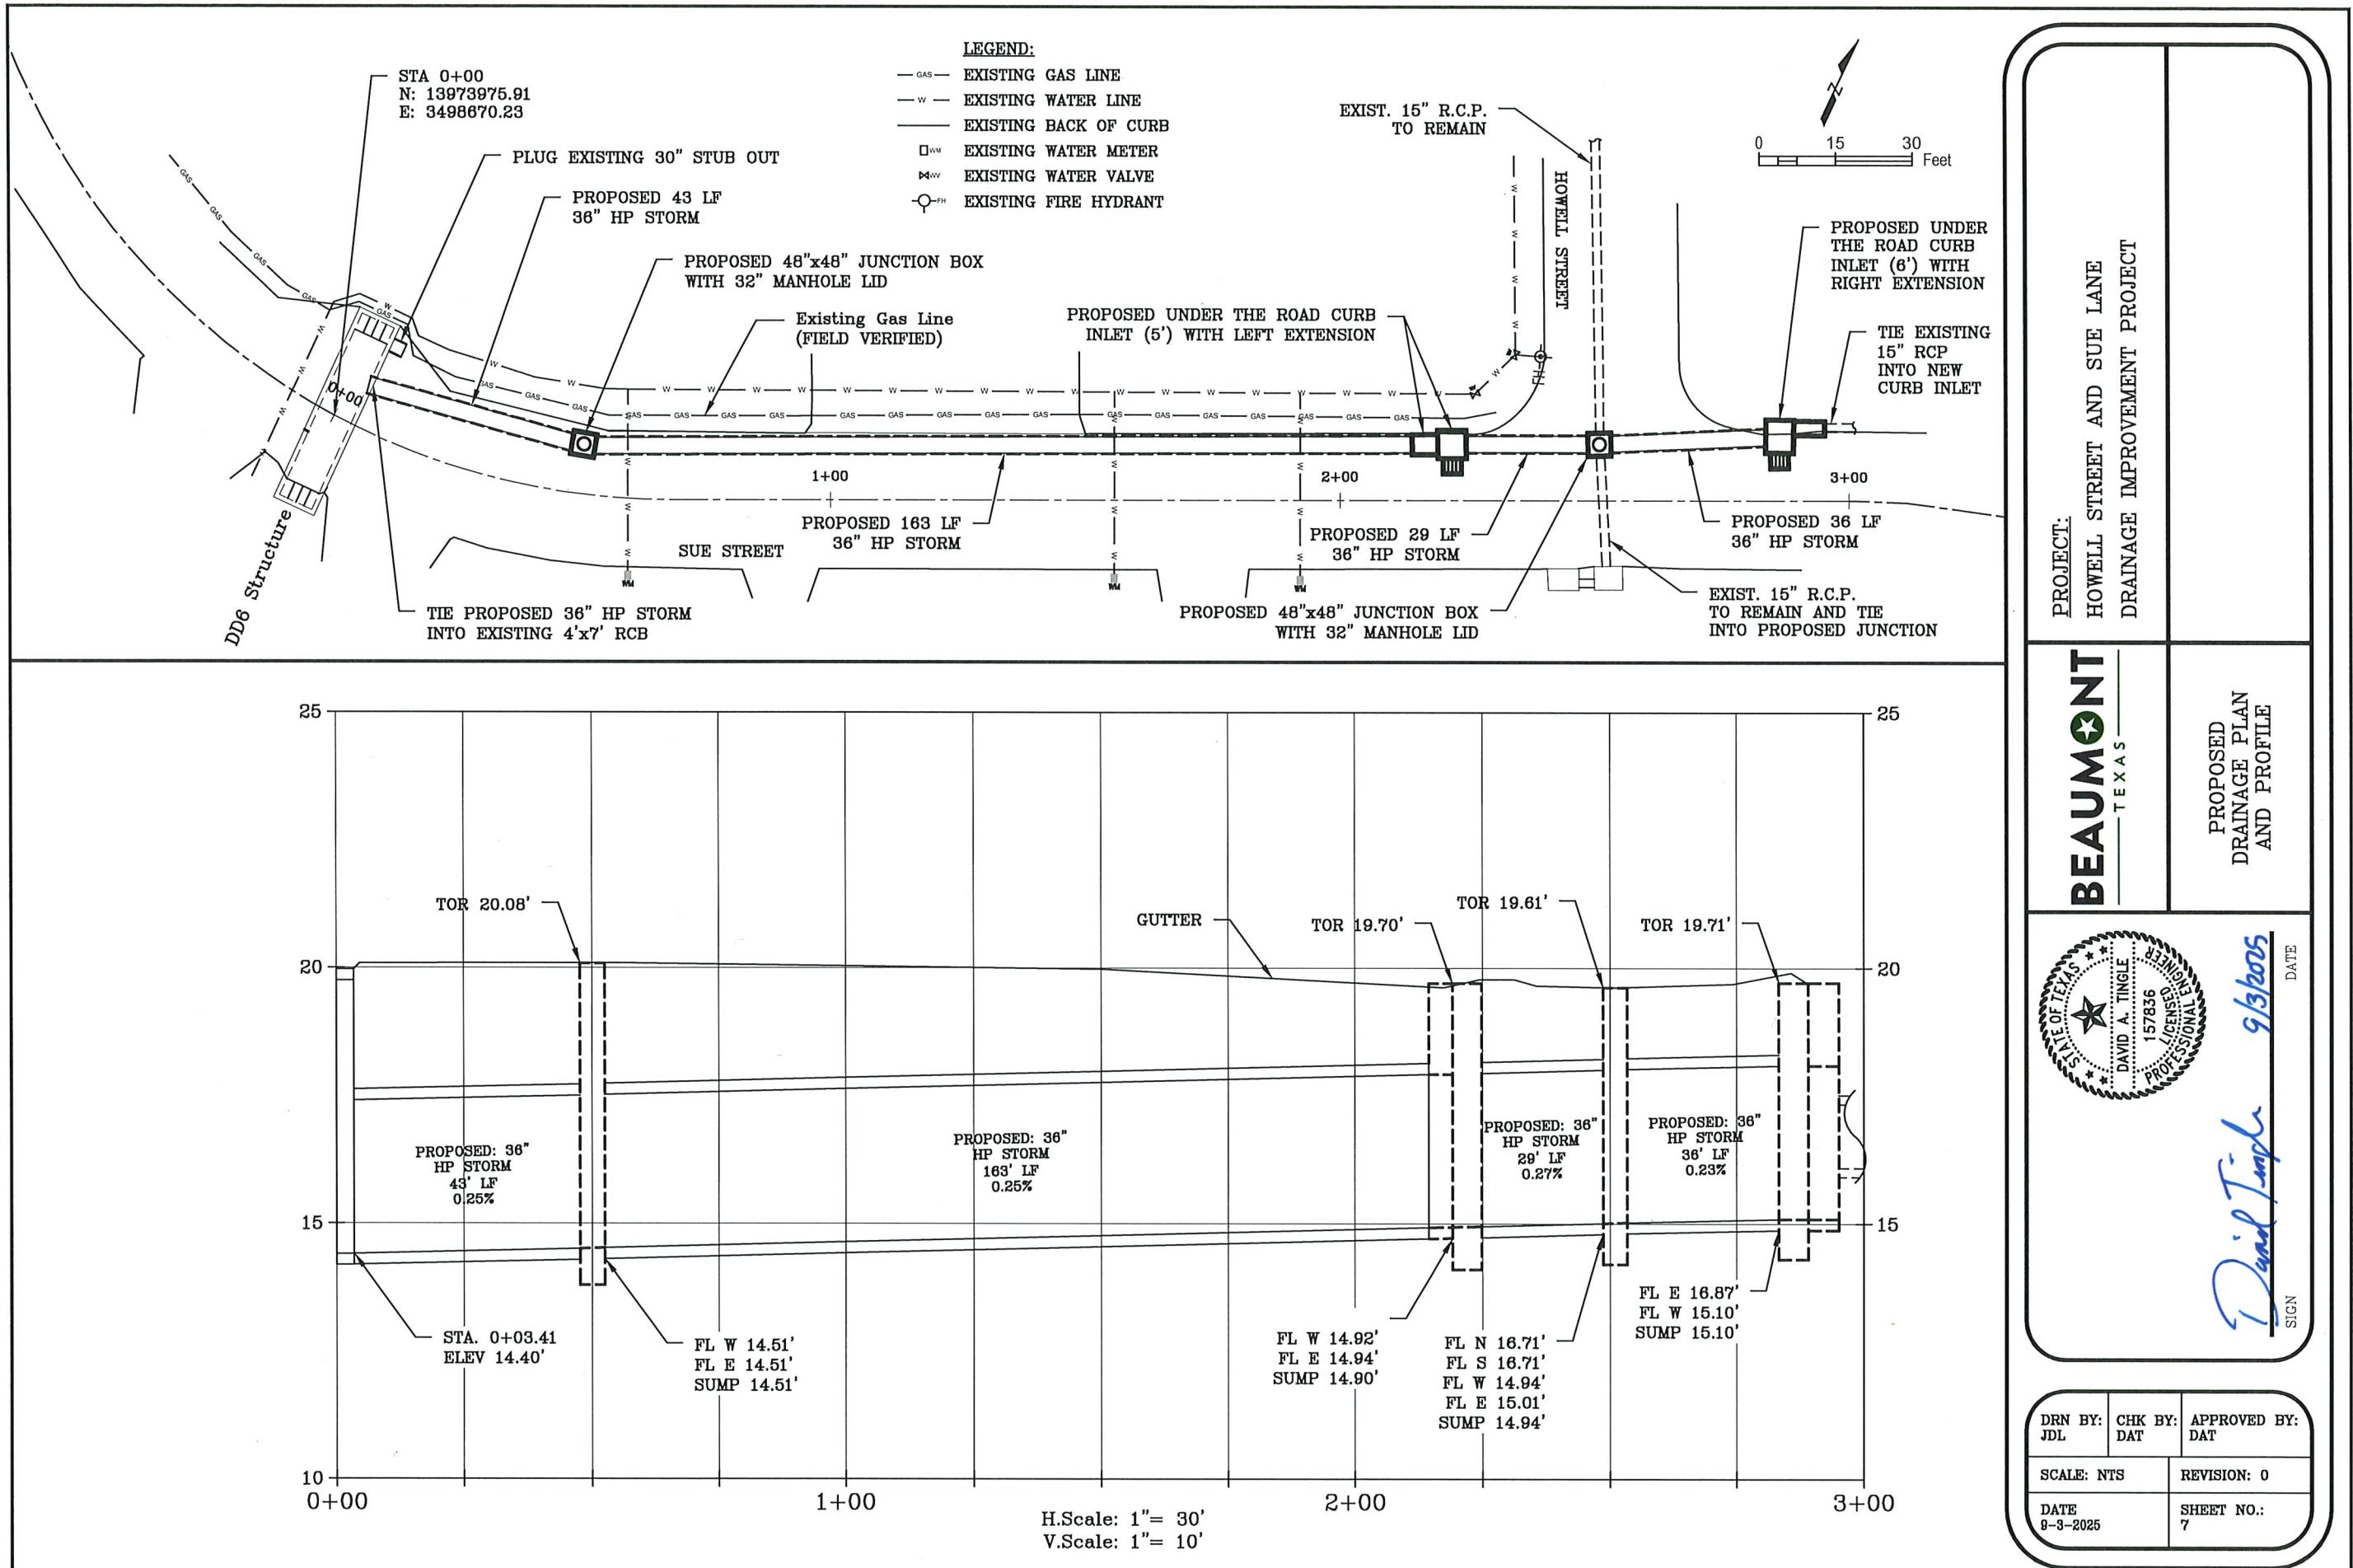


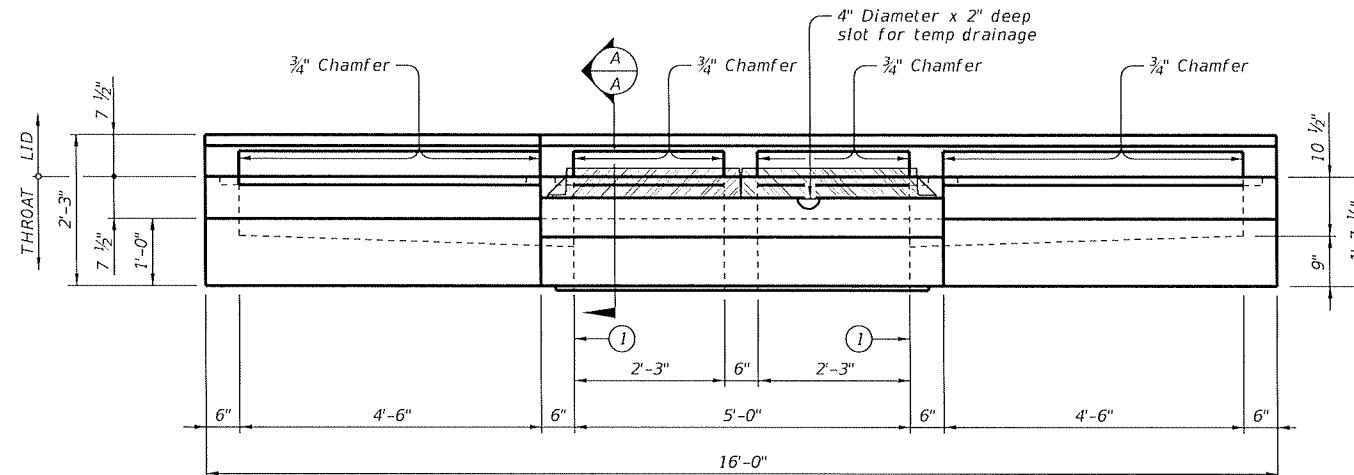


FRONT VIEW
showing left and right extensions

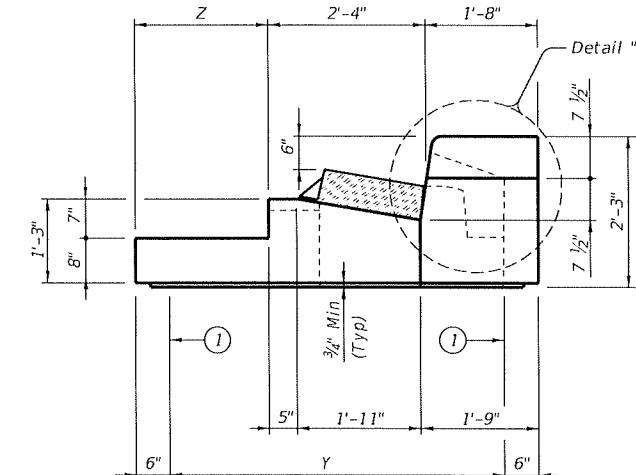

SECTION A-A

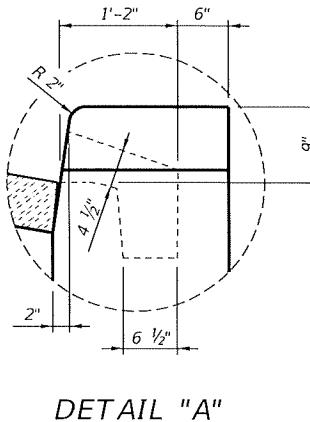

DETAIL "A"

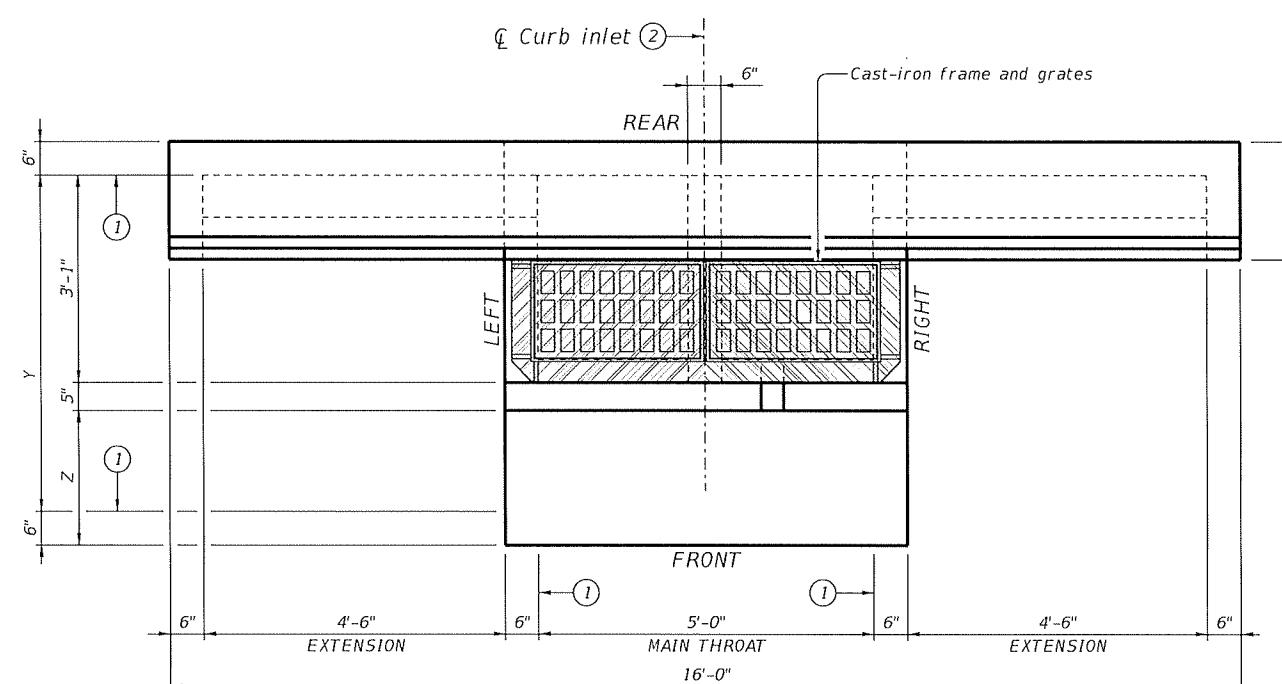


PLAN VIEW
(Showing left and right extensions)

TABLE OF VARIABLE DIMENSIONS	
Size (Y)	Z
3'	0'
4'	1'
5'	2'
6'	3'

① Matches inside face of wall of precast base or riser below inlet.

② Reference point is located where the ℓ of the main throat intersects the normal gutter line. See Curb and Gutter Transition Details for PCO Inlet (CGT-PCO) standard for more information.




HS20 LOADING SHEET 1 OF 2

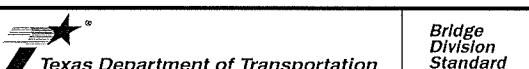

*PRECAST CURB INLET
UNDER ROADWAY*

PCU

E: CD-PCU-23.dgn		TxDOT	Cx. TxDOT		TxDOT	Cx. TxDOT	
TxDOT		February 2020	CONF	SECT	JOB	HIGHWAY	
		REVISIONS					
06-2023: Added reference point.							
				DIST		COUNTY	
						SHEET NO.	

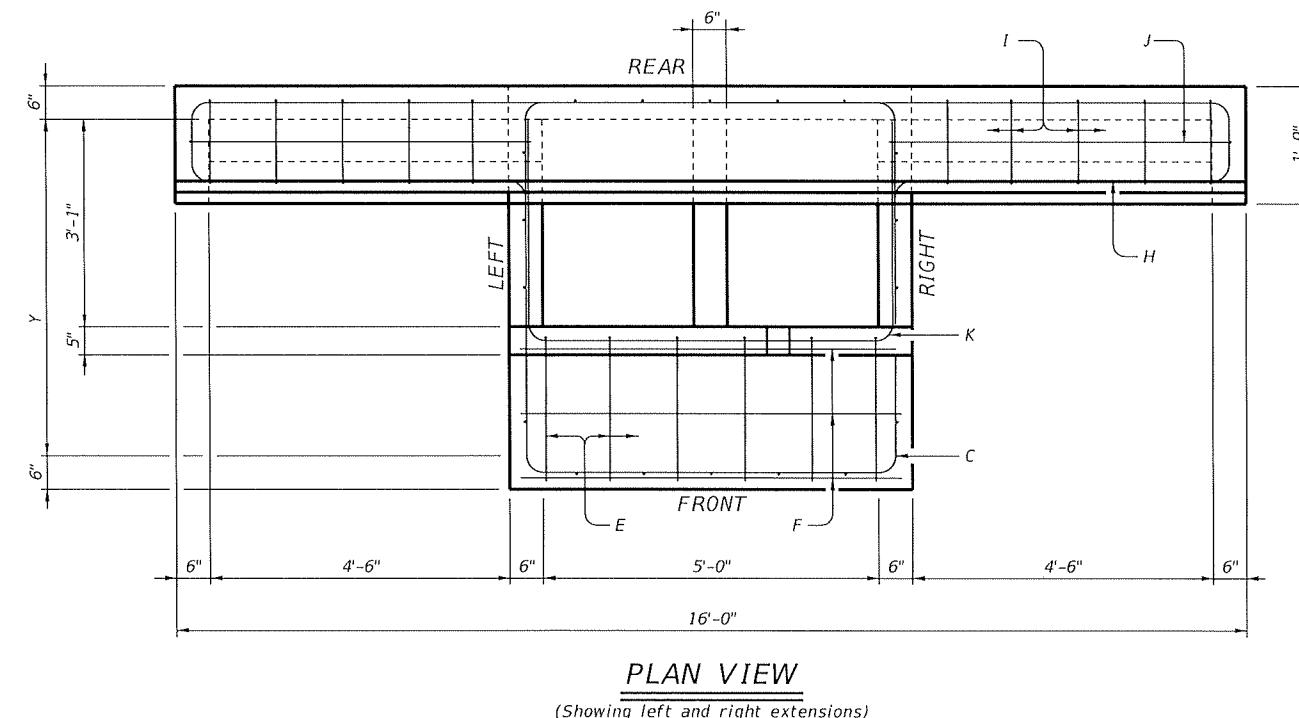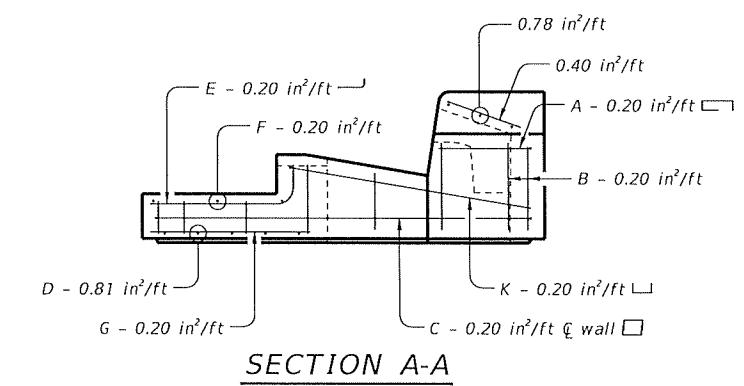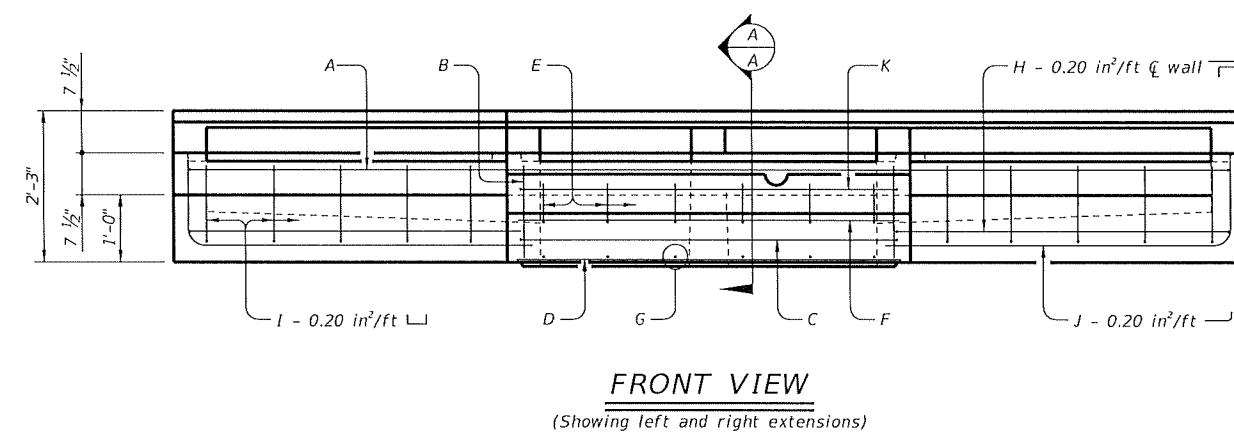

FABRICATION NOTES:

- Provide Class "H" concrete in accordance with Item 421 and having a minimum compressive strength of 5,000 psi.
- Provide Grade 60 reinforcing steel or equivalent area of WWR.
- Provide typical clear cover of 1 1/2" to reinforcing steel from surface of concrete or lower outside shoulder.
- Extensions may be right, left, both or none. Provide extensions as specified elsewhere in plans.
- Design tongue and groove joints for full closure on both shoulders. Minimum spigot depth is 3/4". Top slab may employ a butt joint with dowels at the Contractor's option.
- Provide lifting devices in conformance with Manufacturer's recommendations.
- Chamfer vertical edges on inlet lid 3/4" as shown in Front View, sheet 1.


INSTALLATION NOTES:

- Inlet throat is placed under roadway and intended for direct traffic. Inlet lid is not for direct traffic. Do not place Inlet lid in roadway.
- Seal tongue and groove joints and butt joints with preformed or bulk mastic in conformance with Manufacturer's recommendations. Tongue and groove joints may be grouted no more than 1" between each section, or 1/2 the joint depth, whichever is greater.
- Do not grout rubber gasket joints without Manufacturer's recommendation.

GENERAL NOTES:

- Designed according to ASTM C913.
- Open area of main throat = 324 sq in. Open area of one extension throat = 324 sq in.
- Payment for inlet is per Item 465, "Junction Boxes, Manholes and Inlets" by type, size and extension placement. Extensions are subsidiary to inlet.


HS20 LOADING SHEET 2 OF 2

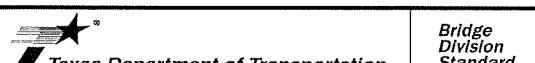


**PRECAST CURB INLET
UNDER ROADWAY**

PCU

FILE: CD-PCU-23.dgn	DN: TxDOT	CN: TxDOT	DW: TxDOT	CK: TxDOT
©TxDOT	February 2020	CONT	SECT	JOB
REVISIONS				
06-2023: Added reference point.	DIST	COUNTY	SHEET NO.	

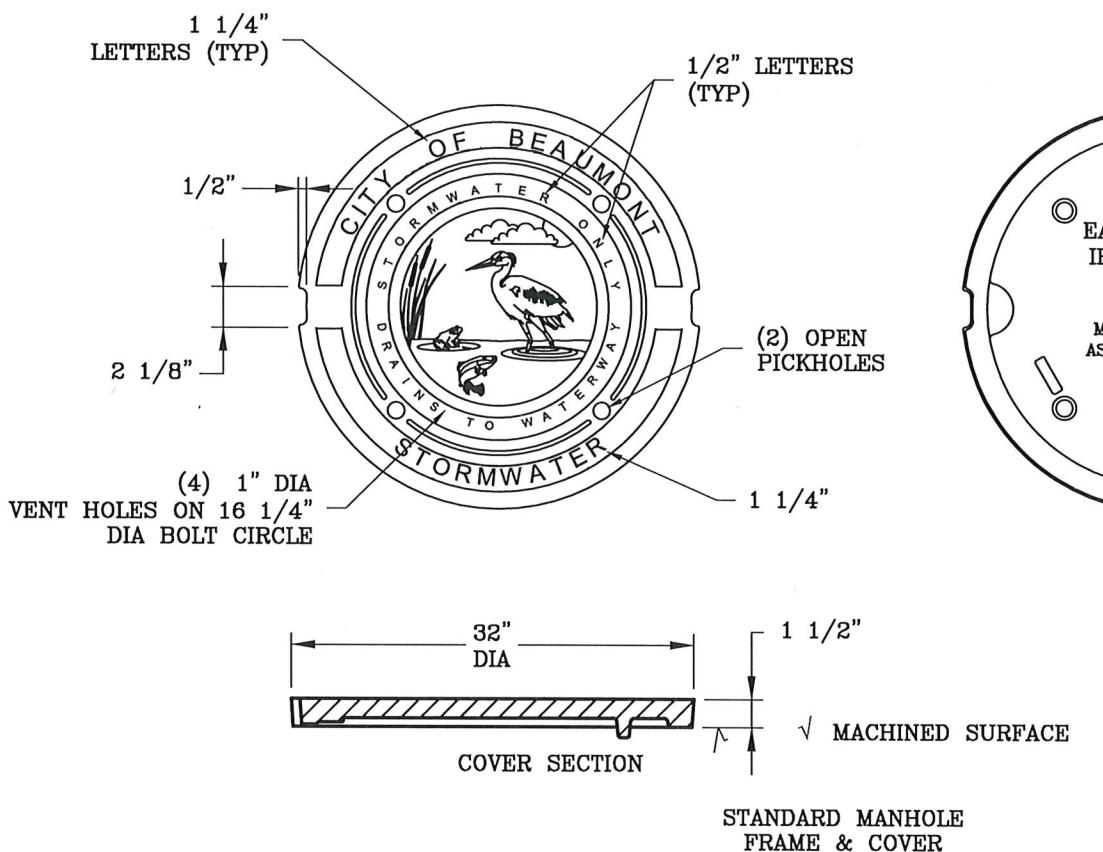

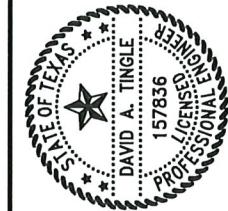PROJECT: HOWELL STREET AND SUE LANE DRAINAGE IMPROVEMENT PROJECT		STANDARD MANHOLE FRAME AND COVER DETAIL
BEAUMONT TEXAS		
 DAVID A. TINGLE 157836 LICENSED PROFESSIONAL ENGINEER		DATE 9/3/2005
DRN BY: JDL	CHK BY: DAT	APPROVED BY: DAT
SCALE: NTS		REVISION: 0
DATE 9-3-2025		SHEET NO.: 14

David Tingle SIGN